### Management Goals & Strategies

## 1 Campus Point Coastal Access

**Goal #1:** Install a stairway on the north side of campus point to reduce erosion and improve public safety.

## 2 Lagoon Island Coastal Access

**Goal #1:** Manage trail locations to reduce erosion and damage to sensitive habitats.

### Trail Legend

existing main trail / emergency access - paved road

existing secondary trail - informal dirt trailproposed or relocated trail


⊗ ⊗ ⊗ existing trail closure - restored with native vegetation

living fence of shrubs to prevent pedestrian access to sensitive areas



potential location of interpretive and educational signage pedestrian access and environmental protection signage areas of revegetation to prevent foot traffic and erosion

proposed locations for informal seating such as wood logs

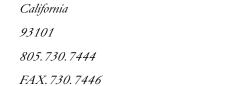

04-17

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Planning

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Landscape Architecture +

UCSB LAGOON RESTORATION

FM050619/238-81

Coastal Access Plan

issue date: December, 2009
plot date: December 17, 2009

drawn by:

# NAME

revisions

# NAME

N S

scale: 1" = 100'-0"

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Exhibit 2 - Photos and Figures


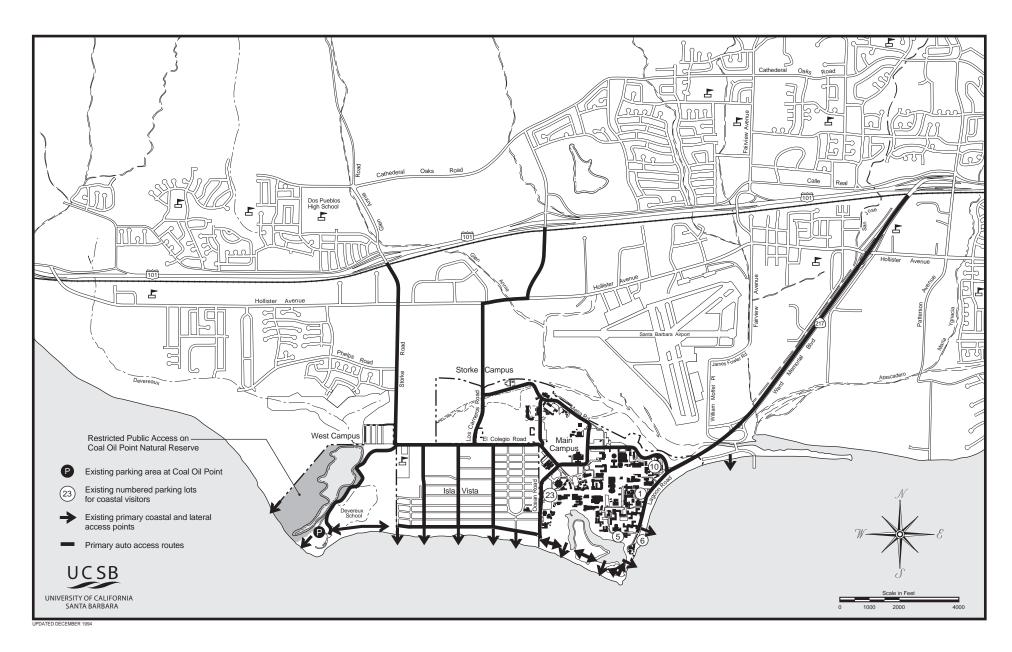


Figure 26 Existing Coastal Access



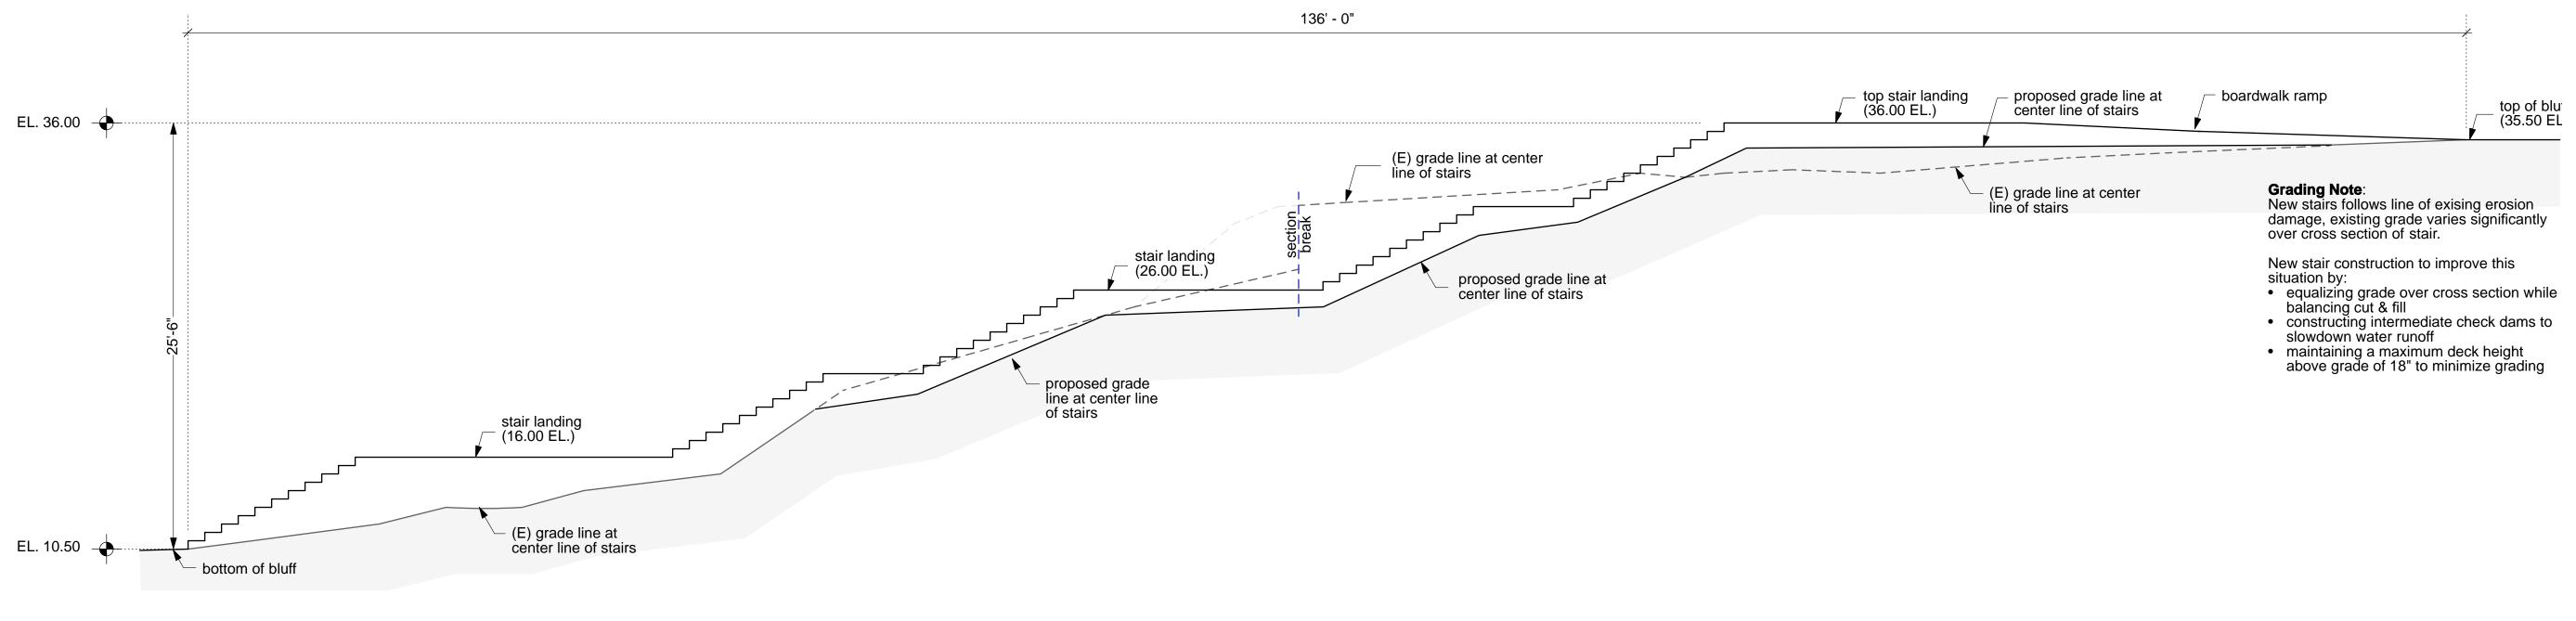

**A** - view of current bluff conditions @ proposed campus point stairs showing multiple existing trails and gullies

scale: 3/16" = 1' - 0"



scale: 3/16" = 1' - 0"

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issue date: November 2009 plot date: November 06, 2009

revisions

scale: as noted

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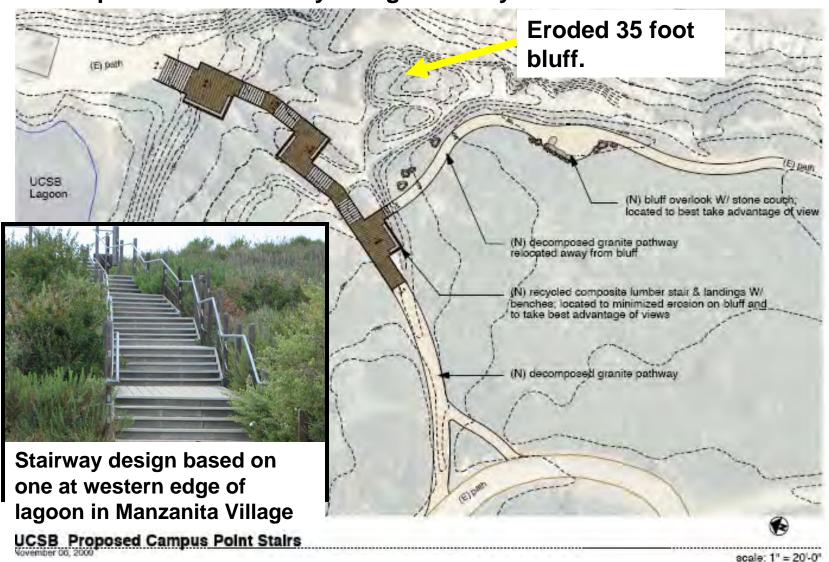
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Campus Point Stairs

**Campus Point Stairs Section** 

# **Stairway site plan and topographic map:** Coastal Trail, public access & bluff protection: Stairway Design and Layout



#### Figure 1. Photos of Project Site: major control points

A- C = Views of erosion from top and bottom of bluff: requires boardwalk style stairway access project.

D& E = Alternate routes: D – beach route blocked by high tide. E- Lagoon shore route is narrow, often wet.

Does not go to major view point, and impacts delicate salt marsh plant community. Both are unsuitable as







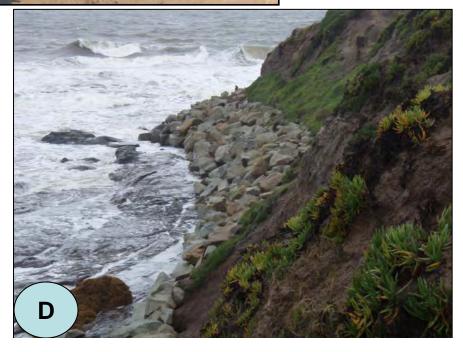




Figure 4. Educational Signage on Coastal Trail adjacent to proposed restoration area. Seven signs will be on this section of Coastal Trail covering: Dune plants, Dune restoration activities, Coastal dune and ocean forces (wind, tide, seasonality), shorebird adaptations, waterbird foraging adaptations, wading and fishing bird habitats, Campus Lagoon geology.

